


PLANT SCHEDULE

TREES	QTY	BOTANICAL / COMMON NAME	CONT	CAL	SIZE	DETAIL
	2	Acer rubrum / Red Maple Shade native wetland species	15 gal	1" Cal		
	5	Amelanchier alnifolia / Serviceberry	5 gal			
	4	Picea abies / Norway Spruce	B & B		7-8' ht.	
	2	Quercus bicolor 'Green Nova' TM / Sun Breaker Swamp White Oak Shade native wetland	B & B			
EVERGREEN TREES	QTY	BOTANICAL / COMMON NAME	CONT	CAL	SIZE	DETAIL
	3	Picea rubens / Red Spruce Native, wetland mitigation	B & B		5-6' ht.	
SHRUBS	QTY	BOTANICAL / COMMON NAME	SIZE	FIELD2	FIELD3	DETAIL
	10	Clethra alnifolia / Summersweet	5 gal			
	12	Cornus stolonifera / Red Twig Dogwood	5 gal			
	6	Ilex verticillata / Winterberry	5 gal			

X >10" DBH SPRUCE/PINE REMOVED
APPROX. LOCATION BASED ON PHOTO MAPPING,
OCTOBER/DECEMBER 2020, CLIENT & JOHN SCOTT
TREE SERVICE INFO.

GRADING LEGEND

- S=0.0% = DIRECTION OF SURFACE DRAINAGE FLOW ROUTE
- 153.1 FG = SPOT ELEVATION (PROPOSED)
- 153.5 FG = SPOT ELEVATION GRADE POINT (EXISTING)
- 155 = EX. CONTOUR ELEVATION
- PROPOSED CONTOUR ELEVATION
- EX. WELL
- 8" HDPE S=0.5% = SETBACK LINE
- PROPERTY LINE
- RETAINING WALL
- FENCE
- POOL MECHANICALS
- POOL MAIN DRAINS (2)
- NATURAL GAS LINE
- BS = BOTTOM OF STEPS
- CB = CATCH BASIN
- CO = CLEAN OUT
- DI = DRAIN INLET
- FF = FINISH FLOOR
- FG = FINISHED GRADE
- FS = FINISHED SURFACE
- FL = FLOW LINE
- GB = GRADE BREAK
- GP = GRADE POINT
- HP = HIGH POINT
- INV = INVERT ELEVATION
- MH = MANHOLE
- RIM = RIM ELEVATION
- TS = TOP OF BERM
- TC = TOP OF CURB
- TF = TOP OF FOOTING
- TG = TOP OF GRATE
- TP = TOP OF PAVING
- TS = TOP OF STEPS
- TW = TOP OF WALL

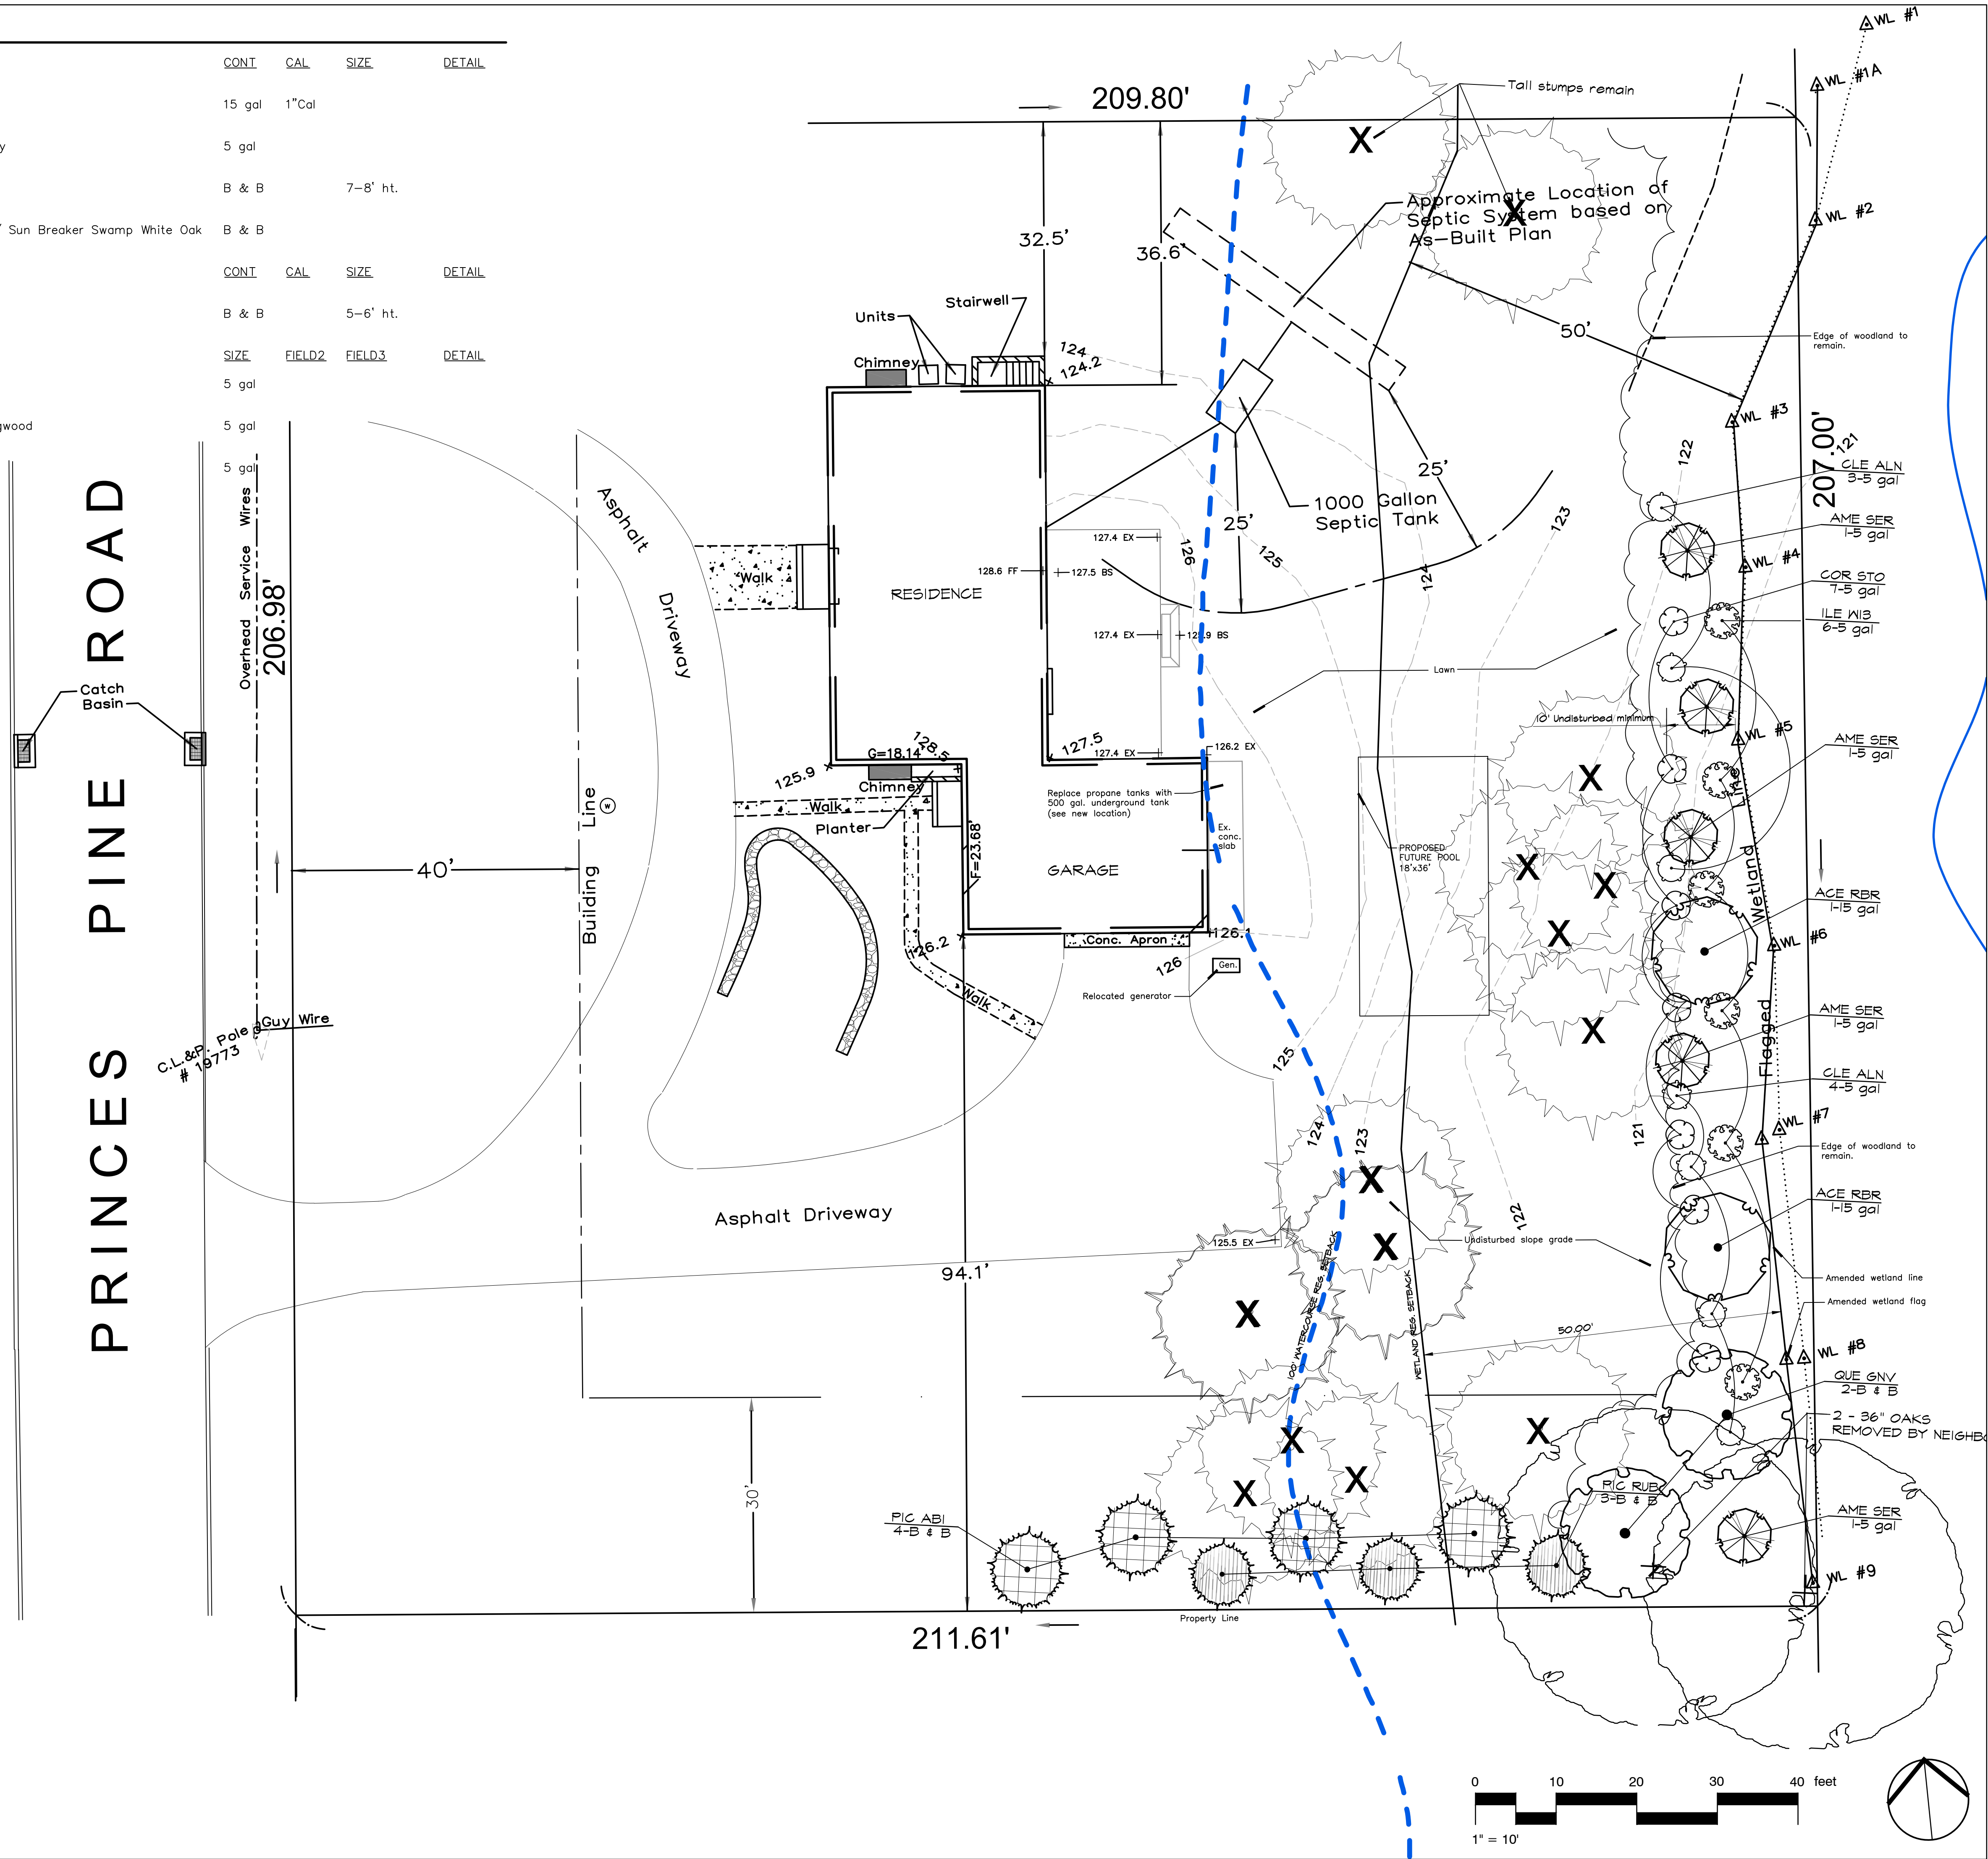

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**Corrective Regulated Area
Site Plan**

Revisions / Issued
Wetland flagging - 5.21.2012 Amended/Otto Theal
100' Watercourse setback line
Ex. Spruce & Pines removed 2020, aerial location

Remediation Plan - 6.17.2021
Revised plant schedule - 6.28.2021

Date 5.21.2021 Sheet No.
Scale 1" = 10'-0" **SP-1**
Project No. 202237

